
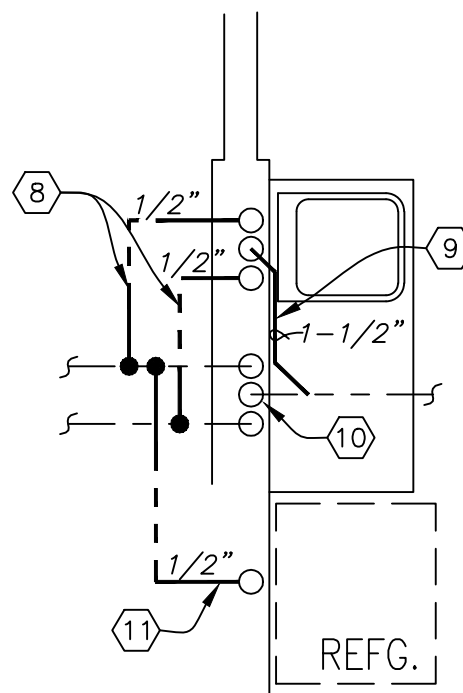
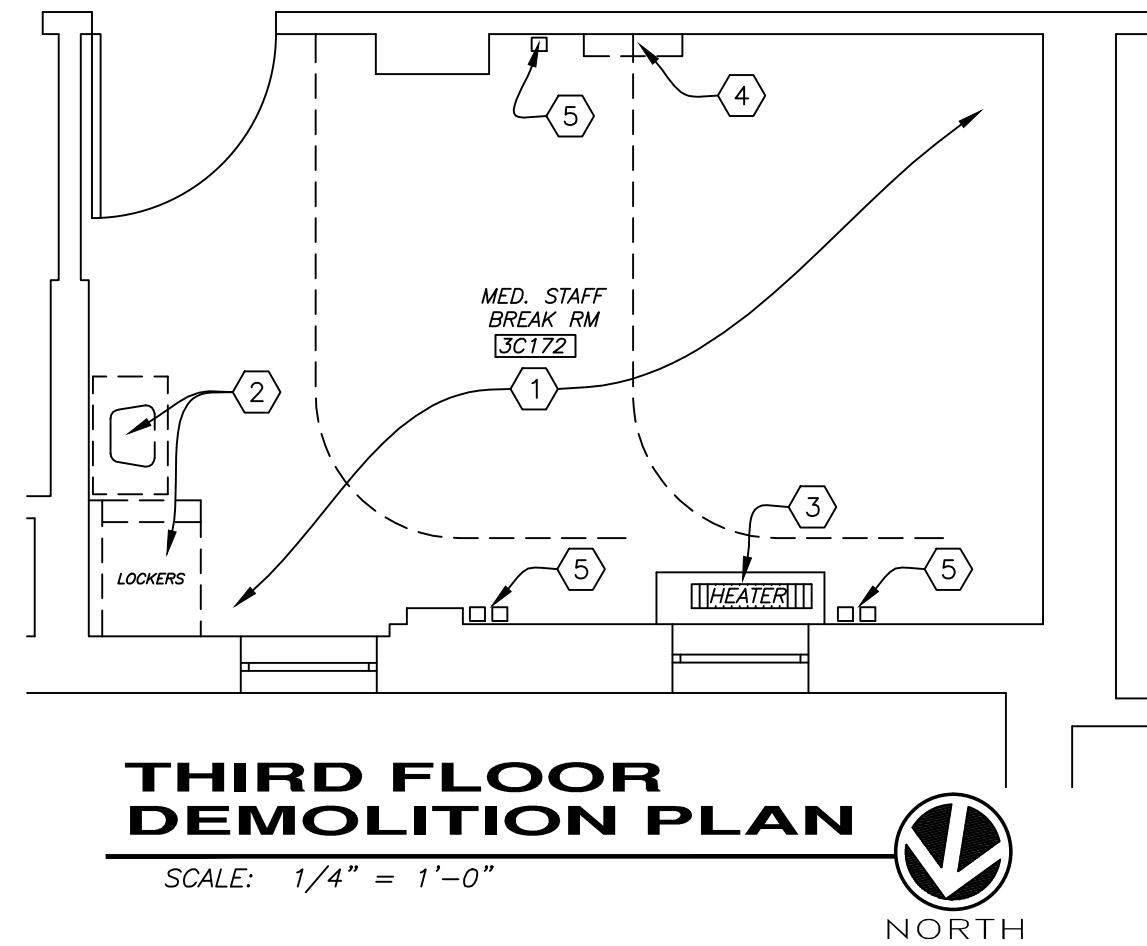


CEILING PLAN LEGEND

- 2x4 LED LIGHTING (VA PROVIDED)
- SUPPLY VENT
- RETURN VENT
- SP X SPRINKLER HEAD

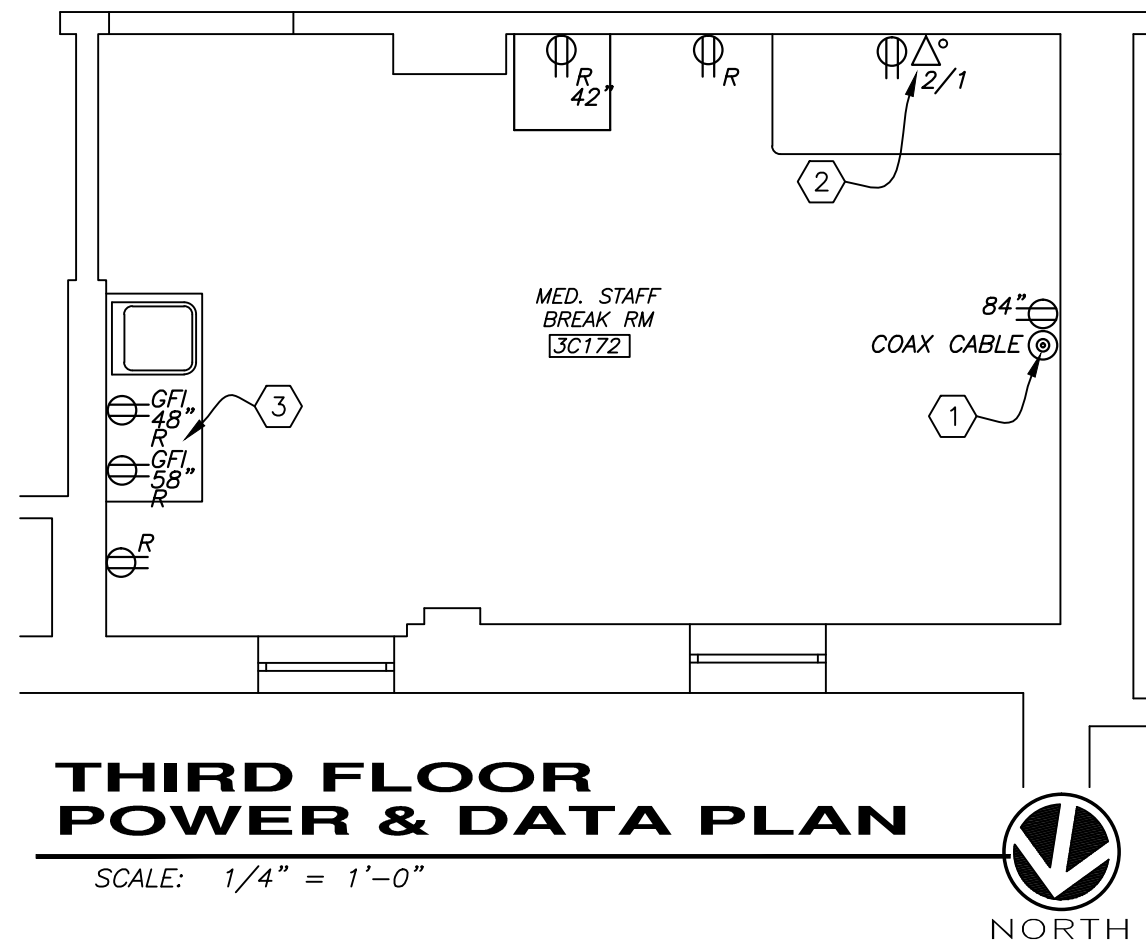

PARTIAL PLUMBING PLAN

SCALE: 3/8" = 1'-0"

CONSTRUCTION NOTES

- 1 FLOORS, WALLS & CEILING TO RECEIVE NEW FINISHES. SEE FINISH SCHEDULE.
- 2 DRILL 2"Ø HOLE & INSERT GROMMET RINGS AS SHOWN IN NEW COUNTERTOP.
- 3 RE PLUMB NEW WASTE AND WATER PIPING TO NEW SINK FIXTURE. SEE PARTIAL PLUMBING PLAN THIS SHEET.
- 4 NEW 2x2 CEILING TILE, GRID, HVAC DIFFUSER, GRILLS & LIGHTING. SEE FINISH SCHEDULE. RECESS CEILING TILE TO EXPOSE ENTIRE WINDOW OPENINGS.
- 5 REPLACE EXISTING HVAC GRILLES WITH NEW. RECONNECT TO EXISTING DUCTWORK.
- 6 INSTALL VA PROVIDED 2x4 LIGHT FIXTURES CONNECT TO NORMAL LIGHTING CIRCUIT.
- 7 INSTALL NEW LIGHT SWITCH TO CONTROL 2x4 LIGHT FIXTURES.
- 8 INSTALL NEW 1/2" COPPER SUPPLY PIPING TO NEW FIXTURES. ALL PIPING SHALL HAVE A MINIMUM 1/2" INSULATION. REFER TO MFG. CUT SHEETS FOR LOCATION TIE IN POINT AS NEEDED. WORK INCLUDES ALL CONNECTIONS AND MOUNTING SUPPORT HANGERS AS REQ. IN ACCORDANCE WITH LOCAL CODE.
- 9 INSTALL NEW 1-1/2" SEWER PIPE FROM FIXTURES TO EXIST. SEWER PIPE. PROVIDE REDUCERS AS REQ. REFER TO MFG. CUT SHEETS FOR LOCATION TIE IN POINT. WORK INCLUDES REDUCER CONNECTIONS AND ALL MOUNTING SUPPORT HANGERS AS REQ. IN ACCORDANCE WITH LOCAL CODE. INSTALL & TIE NEW VENT PIPE TO NEAREST RISER.
- 10 RE-USE EXISTING WATER LINE AND DRAINS TO CONNECT NEW FIXTURES & SHOWER.
- 11 INSTALL WATER LINE CONNECTOR WITH INDIVIDUAL SHUTOFF FOR BUILT IN REFRIGERATOR ICE MACHINE UNIT.

ELECTRICAL NOTES

- 1 INSTALL NEW COAX CABLE OUTLET IN WALL. REQUIRES ROUTING A NEW CABLE ABOVE CEILING TO CLOSEST CLOSET COORDINATE WORK WITH VA COR AND ELECTRICAL DEPT.
- 2 INSTALL NEW DATA/COMM OUTLET. PER DATA NOTES REFERENCED ON SHEET E1.
- 3 INSTALL NEW ELECTRIC OUTLETS PER ELECTRIC/DATA NOTES AND LEGEND REFERENCED ON SHEET E1. TYPICAL ALL NEW OUTLETS.

DEMOLITION NOTES

- 1 ENTIRE ROOM TO RECEIVE NEW FINISHES. REMOVE EXISTING VCT FLOORING. REMOVE COVE BASE WHERE IT EXISTS. REMOVE EXISTING LIGHTING, SUSPENDED CEILING TILE & GRID. PATCH FLOORS & WALLS AS REQUIRED FOR NEW FINISH. REMOVE WALL HUNG ITEMS AND STORE APPROPRIATELY AS DIRECTED BY COR FOR RE-INSTALLATION. APPLY ARDEX SELF LEVELING CONCRETE UNDERLAMENT AS REQUIRED.
- 2 REMOVE LOCKERS, PARTITION WALL, CASEWORK & PLUMBING FIXTURE. PATCH FLOORS & WALLS AS REQUIRED FOR NEW FINISH. PLUMBING CONTRACTOR TO REMOVE EXIST. PLUMBING FIXTURES AND PREPARE TO RECEIVE NEW FIXTURE AS SHOWN.
- 3 REMOVE HEATING COIL UNIT COMPONENTS AS NEEDED TO CLEAN THOROUGHLY & REFURBISH UNIT FOR RE-USE. EXTERIOR FINISH SURFACE SHALL BE CLEANED SANDED, PATCHED AS REQUIRED AND PAINTED WITH EPOXY BASE PAINT.
- 4 REMOVE PATIENT HEADWALL UNIT. OXYGEN, MEDICAL AIR & VACUUM LINES SHALL BE DISCONNECTED, CAPPED & CERTIFIED COMPLIANT BY REGISTERED MEDICAL GAS TECHNICIAN. DISCONNECT NURSE CALL, COMM LINES AND ELECTRIC BACK TO NEAREST JUNCTION BOX.
- 5 DISCONNECT & REMOVE ALL SURFACE & POLE MOUNTED OUTLETS, COM DEVICES AND ASSOCIATED EXPOSED CONDUITS. EXISTING TV OUTLETS SHALL BE REMOVED, AND HOLES PATCHED OVER TO RECEIVE PAINT.

PLUMBING FIXTURE SCHEDULE

| P# | DESCRIPTION | CW | HW | SAN | VENT | TRAP | NOTES |
|-------|---------------------|------|------|--------|--------|------|-------------------|
| P-105 | COUNTERTOP S/S SINK | 1/2" | 1/2" | 1-1/2" | 1-1/2" | P | SEE NOTES 1, 2, 3 |

ADDITIONAL NOTES:

1. PLUMBING TIE INS OF NEW FIXTURES WILL REQUIRE MODIFYING SUPPLY AND DRAIN LINES, CORING NEW HOLES THRU WALLS AND FLOORS, ETC. AND SHALL BE INCLUDED AS PART THE INSTALLATION.
2. INCLUDES SINGLE BOWL STAINLESS STEEL SINK, GOOSENECK SPOUT FAUCET & PULL OUT SPRAY HEAD.
3. FIXTURE SHALL BE RATED TO DISPENSE WATER AT A RATE OF 2.5 GALLON PER MINUTE (GPM).

ROOM FINISH SCHEDULE

| RM.NO. | ROOM NAME | FLOOR FINISH | BASE | WALLS | CEILING | NOTES |
|--------|-----------|--------------|------|-------|---------|--------------------------|
| 3C172 | LOUNGE | RES-1,2 | RB | P1,2 | ACT | SEE NOTES 1, 2, 3, 4, 5. |

MATERIAL FINISH LEGEND

ACCOUSTIC CEILING TILE (ACT) RUBBER BASE (RB)
RESILANT FLOORING (RES) PAINT (P)

FINISH NOTES:


1. ACCOUSTIC CEILING TILE (ACT) SHALL BE 2x2 LAY IN TYPE, WASHABLE, MOLD, BACTERIA & MILDEW RESISTANT. INSTALL NEW GRID.
2. PAINT (P) 1 COAT SHERWIN WILLIAMS MULTI-PURPOSE LATEX PRIMER, 2 COATS SHERWIN WILLIAMS SEMI GLOSS LATEX FINISH. COLOR REFER TO MATERIAL & COLOR LEGEND.
3. RUBBER BASE (RB) SHALL BE 5-1/4" HIGH WITH CONTOUR, COLOR - MANNINGTON 918 FLAX.
4. RESILANT FLOORING (RES) TWO COLOR PATTERN T.B.D. REFER TO FLOOR PATTERN LAYOUT AND MATERIAL & COLOR LEGEND SHEET A2.
5. ONE ACCENT WALL SHALL BE PAINTED THIS ROOM. ENTIRE DOOR & FRAME SHALL BE PAINTED REFER TO MATERIAL & COLOR LEGEND SHEET A2.

CASEWORK SCHEDULE

| CASEWORK NUMBER | MANUFACTURER'S SERIES | S I Z E | | | CASEWORK TYPE | ADJ. SHELF | DOORS | DRWRS | REMARKS |
|-----------------|-----------------------|---------|-----|-----|---------------|------------|-------|-------|---------|
| | | W" | H" | D" | | | | | |
| B1 | | 18" | 36" | 23" | DRAWERS | - | - | 4 | |
| B2 | | 18" | 36" | 23" | DOOR/DRAWER | 1 | 1 | 1 | |
| B3 | | 18" | 36" | 23" | SINK CABINET | - | 1 | - | |
| B4 | | 24" | 36" | 23" | DOOR/DRAWER | - | 1 | 1 | |
| W1 | | 30" | 18" | 16" | HINGED DOORS | 1 | 2 | - | |
| W2 | | 18" | 18" | 16" | HINGED DOORS | 1 | 2 | - | |
| W3 | | 24" | 16" | 16" | MICRO WAVE | - | - | - | |


CASEWORK NOTES

GENERAL CONTRACTOR TO VERIFY SIZE OF COUNTERTOPS. ALL CABINET JOINTS ARE TO BE FLUSH WITHOUT OVERLAPS. FIXTURES AND CONNECTIONS BY PLUMBING CONTRACTOR. COUNTERTOPS SHALL HAVE 4" H BACK SPLASH, FIELD JOINT & MARINE EDGED. COUNTERTOPS & BACKSPLASH SHALL BE SOLID SURFACE CORIAN. PROVIDE REAR, FRONT & CORNER FILLERS (SIZE VARIES) AS REQUIRED. ALL CASEWORK IS TO HAVE SOLID BACKS. ALL DIMENSIONS SHOWN ON CASEWORK SCHEDULE ARE NOMINAL DIMENSIONS.

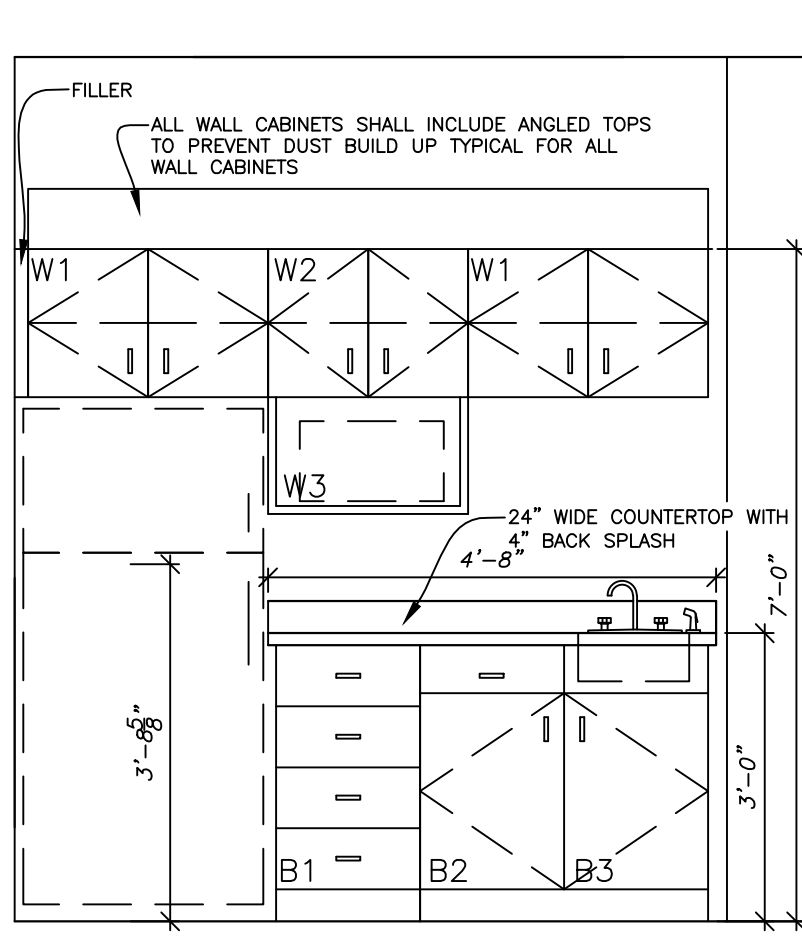


ELEVATION A

SCALE: 1/2" = 1'-0"

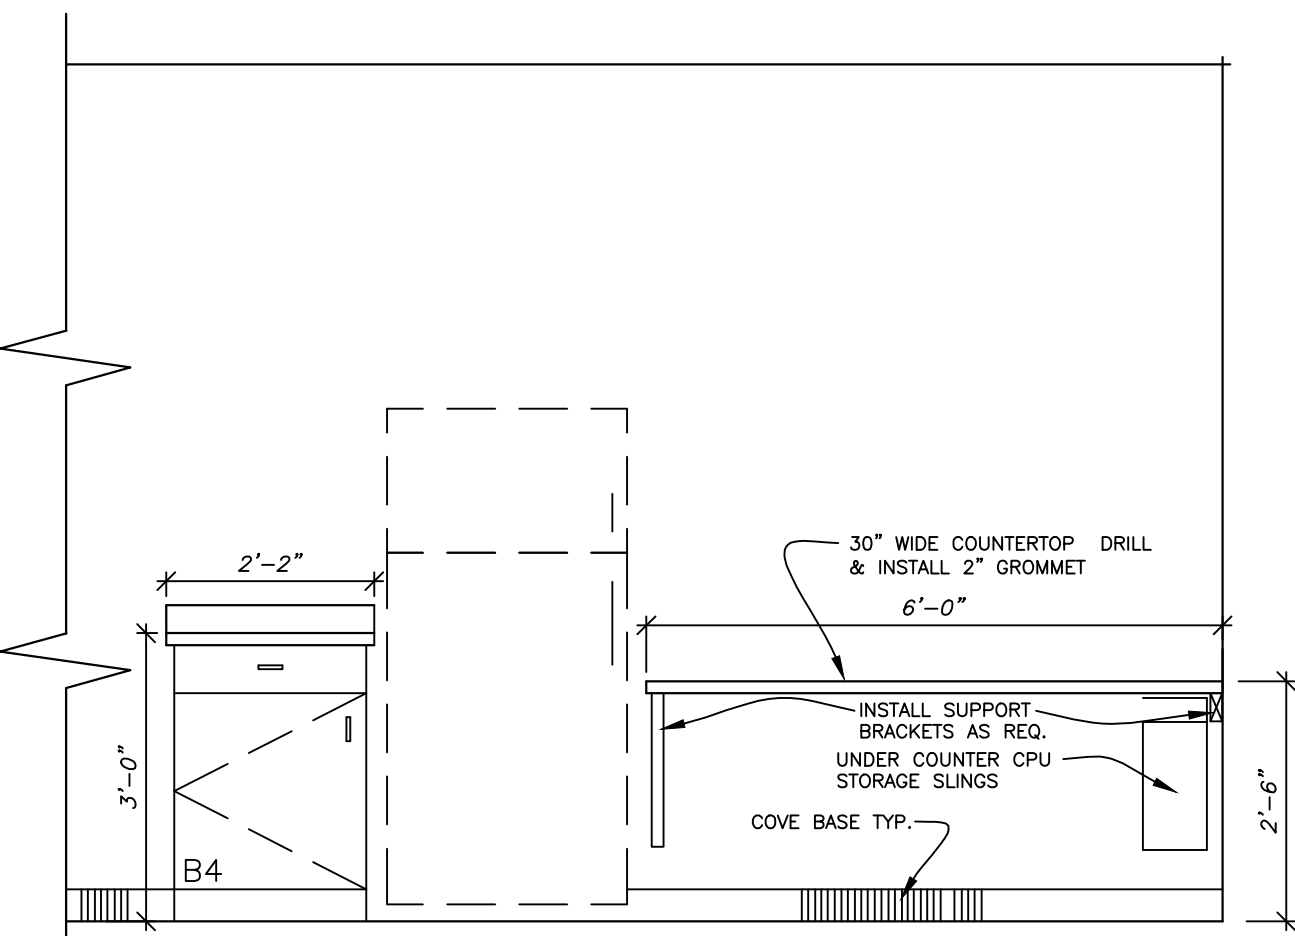

ELEVATION B


SCALE: 1/2" = 1'-0"

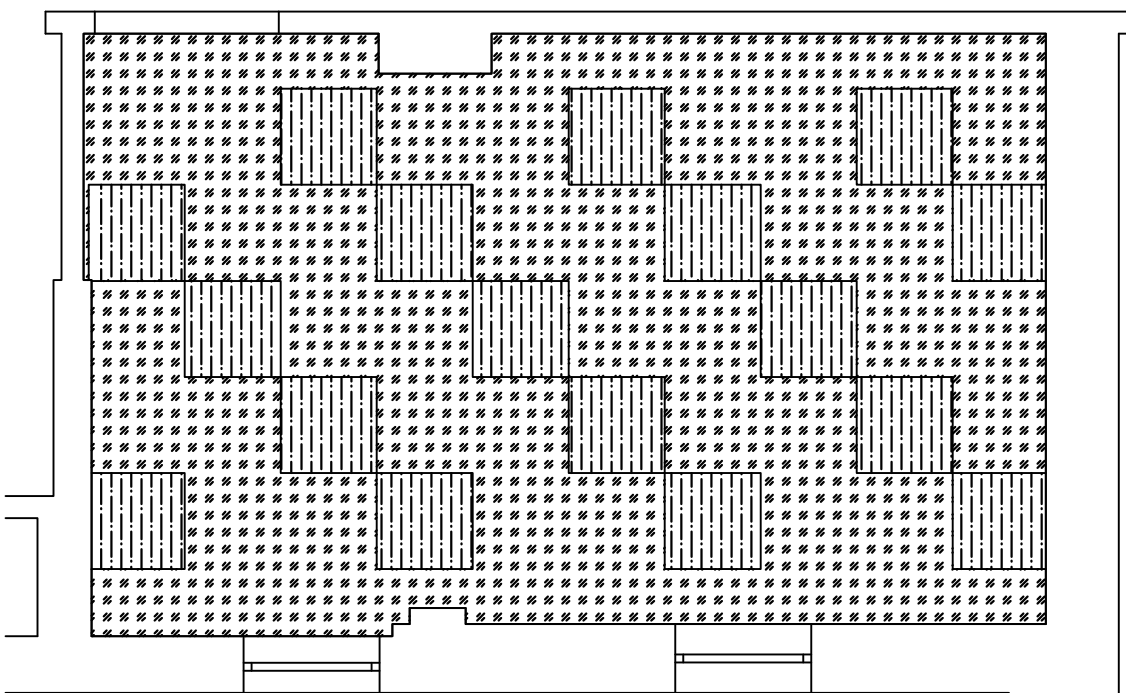

THIRD FLOOR FLOOR PATTERN PLAN

SCALE: 1/4" = 1'-0"

NOTE: FLOOR TILE LAYOUT REPRESENTS "EXAMPLE ONLY". FINAL FLOOR PATTERN SHALL BE FIELD DETERMINED BY VA INTERIOR DESIGN REPRESENTATIVE.

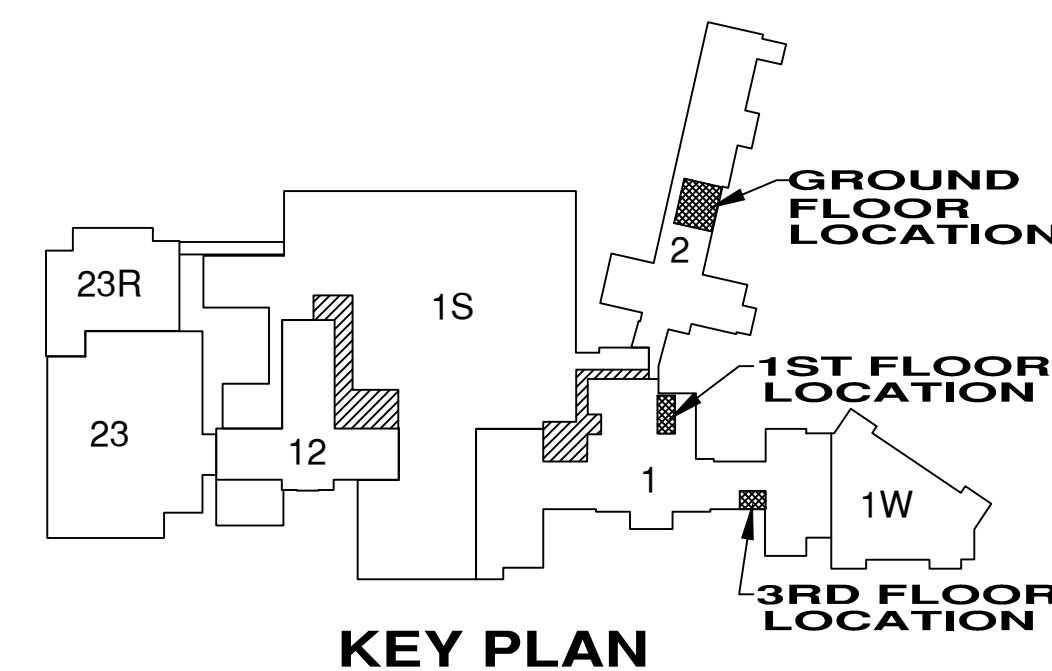

KEY PLAN



UNITED STATES DEPARTMENT OF VETERANS AFFAIRS
VA MEDICAL CENTER - 1540 SPRING VALLEY DRIVE - HUNTINGTON WV 25704

PLANS, ELEVATIONS
SCHEDULES & DETAILS

APPROVED:
CHRIS ECKLES
ASS'T CHIEF, ENGINEERING

APPROVED:
JOHN KLIM
CHIEF, ENGINEERING

LOCKER/BREAKROOM
RENOVATION PROJECT

BUILDING:
1

PROJECT NUMBER:
14-109

DRAWING NUMBER:
A4

DATE:
JAN '14

DWG.